


TEMP. TREE PROTECTION BARRIER - N.T.S.

	EES RECOMMENDED FOR REMOVAL GENERAL INFORMATION SIZE HEALTH					RECOMMENDATION		
	GLINEKAL INI V	JAPIATION	312		CROWN		INL.	COMPLINDATION
ID#	BOTANICAL NAME	COMMON NAME	DBH (cm)	CANOPY RADIUS (m)	CONDITION 1 - DEAD 5 - HEALTHY	STRUCTURAL CONDITION	Proposed Action	RATIONALE
2	Picea omorika	Serbian Spruce	19	2.5	5	good	REMOVE	CONSTRUCTION
4	Picea abies	Norway Spruce	61	6	5	good	REMOVE	CONSTRUCTION
5	Pseudotsuga	Douglas Fir	43	3	4	good	REMOVE	CONSTRUCTION
21	menziesii Rhamnus spp	Buckthorn	10, 8, 4	2	5	fair	REMOVE	INVASIVE SPECIES
22	Picea pungens var. glauca	Colorado Blue Spruce	39	2	2/3	fair	REMOVE	FACILITATE PLANTING HEDGE ROW FOR SCREE
23	Abies balsamea	Balsam Fir	40	3	4	fair	REMOVE	FACILITATE PLANTING HEDGE ROW FOR SCREE
24	Abies balsamea	Balsam Fir	24	2.75	4	good	REMOVE	FACILITATE PLANTING HEDGE ROW FOR SCREE
25	Picea glauca	White Spruce	35	3	5	good	REMOVE	FACILITATE PLANTING HEDGE ROW FOR SCREE
26	Picea glauca	White Spruce	20	3	3	fair	REMOVE	FACILITATE PLANTING HEDGE ROW FOR SCREE
27	Picea glauca	White Spruce	46	3.5	4	good	REMOVE	FACILITATE PLANTING HEDGE ROW FOR SCREE
28	Abies balsamea	Balsam Fir	29	3.5	5	poor	REMOVE	FACILITATE PLANTING HEDGE ROW FOR SCREE
29	Abies balsamea	Balsam Fir	40	3.5	5	good	REMOVE	FACILITATE PLANTING HEDGE ROW FOR SCREE
31	Liquidambar stryaciflua	Sweetgum	26	3	5	good	REMOVE	CONSTRUCTION
32	Malus spp	Apple	18-30	5	4	poor	REMOVE	CONSTRUCTION
34	Cercis canadensis	Redbud	15, 12, 9, 8	4	5	poor	REMOVE	CONSTRUCTION
35	Acer platanoides	Norway Maple	89	7	5	good	REMOVE	CONSTRUCTION
36	Celtis occidentalis	Hackberry	11	2	2	fair	REMOVE	CONDITION
37	Celtis occidentalis	Hackberry	20	2	2	fair	REMOVE	CONDITION
38	Acer platanoides	Norway Maple	11	3	4	fair	REMOVE	CONDITION
39	Acer platanoides	Norway Maple	12	3	4	fair	REMOVE	CONDITION
40	Picea abies	Norway Spruce	58	6	5	good	REMOVE	CONSTRUCTION
41	Acer saccharum	Sugar Maple	78	10	5	poor	REMOVE	CONSTRUCTION
42	Acer saccharum	Sugar Maple	80	8	5	poor	REMOVE	CONSTRUCTION
43	Picea abies	Norway Spruce	56	6	5	good	REMOVE	CONSTRUCTION
44	Acer saccharum	Sugar Maple	31, 31	5	5	fair	REMOVE	CONSTRUCTION
45	Acer platanoides	Norway Maple	24	5	5	good	REMOVE	CONSTRUCTION
46 47	Acer platanoides Juglans nigra	Norway Maple Black Walnut	39 15	5 4	5	good	REMOVE REMOVE	CONSTRUCTION CONSTRUCTION
47	Picea glauca	White Spruce	40	3	4	poor good	REMOVE	CONSTRUCTION
49	Juglans nigra	Black Walnut	44	7	5	fair	REMOVE	CONSTRUCTION
51	Acer saccharum	Sugar Maple	21	3	5	fair	REMOVE	AT NEIGHBOURS REQU
52	Picea glauca	White Spruce	34	3.5	2/3	fair	REMOVE	AT NEIGHBOURS REQU
53 58	Picea glauca Ulmus pumila	White Spruce Siberian Elm	27 42, 38	<u>3</u>	1 4	dead fair	REMOVE REMOVE	CONDITION PARKING LOT CONSTRU
59	Ulmus pumila	Siberian Elm	42, 30	6	4	fair	REMOVE	PARKING LOT CONSTRU
60	Gleditsia triacanthos var.	Honeylocust	44	6	5	fair	REMOVE	PARKING LOT CONSTRU
61	inermis Juglans regia	English Walnut	58, 56, 27	8	4	poor	REMOVE	CONSTRUCTION
67	Rhus typhina	Staghorn Sumac	<10	2	2	fair	REMOVE	SIDEWALK CONSTRUCTI
68	Rhus typhina	Staghorn Sumac	<10	2	2	fair	REMOVE	SIDEWALK CONSTRUCTI SIGHT LINES
69	Rhus typhina	Staghorn Sumac	<10	2	2	fair	REMOVE	SIDEWALK CONSTRUCT SIGHT LINES
70	Abies balsamea	Balsam Fir	30	2	5	fair	REMOVE	PARKING LOT CONSTRU
72	Betula papyrifera	Paper Birch	19, 19, 16, 16	3	5	good	REMOVE	SIDEWALK CONSTRUC
73	Tilia cordata	Little Leaf Linden	10-16	3.5	5	poor	REMOVE	CONDITION
75	Juniperus virginiana	Eastern Red Cedar	41	2.5	5	good	REMOVE	DRIVEWAY CONSTRUC
76	Juniperus virginiana	Eastern Red Cedar	33	2.5	5	fair	REMOVE	DRIVEWAY CONSTRUC



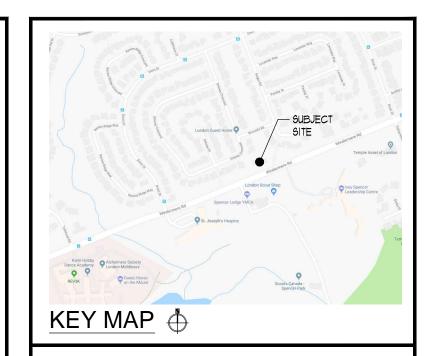


ALL DRAWINGS REMAIN THE PROPERTY OF THE LANDSCAPE ARCHITECT AND SHALL NOT BE REPRODUCED OR REUSED WITHOUT THE LANDSCAPE ARCHITECTS WRITTEN PERMISSION.


THIS DRAWING SHALL NOT BE USED FOR CONSTRUCTION OR TENDER PURPOSES UNLESS SIGNED AND DATED BY RONALD H. KOUDYS, OALA, CSLA, LANDSCAPE ARCHITECT, LONDON, ONTARIO (519) 667-3322.

Ronald H. Koudys, O.A.L.A. C.S.L.A. DATE

DEC 13, 2019	166UED FOR TREE REPLACEMENT	8.
OCT 17, 2019	ISSUED FOR DISCUSSION	٦.
OCT Ø2, 2Ø19	ISSUED FOR SPA	6.
SEPT 27, 2019	166UED FOR REVIEW	5.
MAR 18, 2019	RE ISSUED FOR REZONING	4.
NOV 1, 2018	RE ISSUED FOR REZONING	3.
JULY 19, 2018	166UED FOR REZONING	2.
MAY 17, 2018	166UED FOR REVIEW	1.
DATE	DESCRIPTION	No.

PLOTTED DATE = DECEMBER 13, 2019 PLOTTED SCALE = 1:1

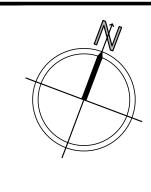

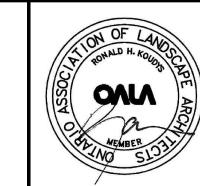


536-542 WINDERMERE RD LONDON, ON

DRAWING TITLE:

TREE PRESERVATION PLAN

DATE:	SCALE:	DRAWING No.
MAY 2018	AS NOTED	
DRAWN: RKLA Inc.	CHECKED BY:	
PROJECT No.		

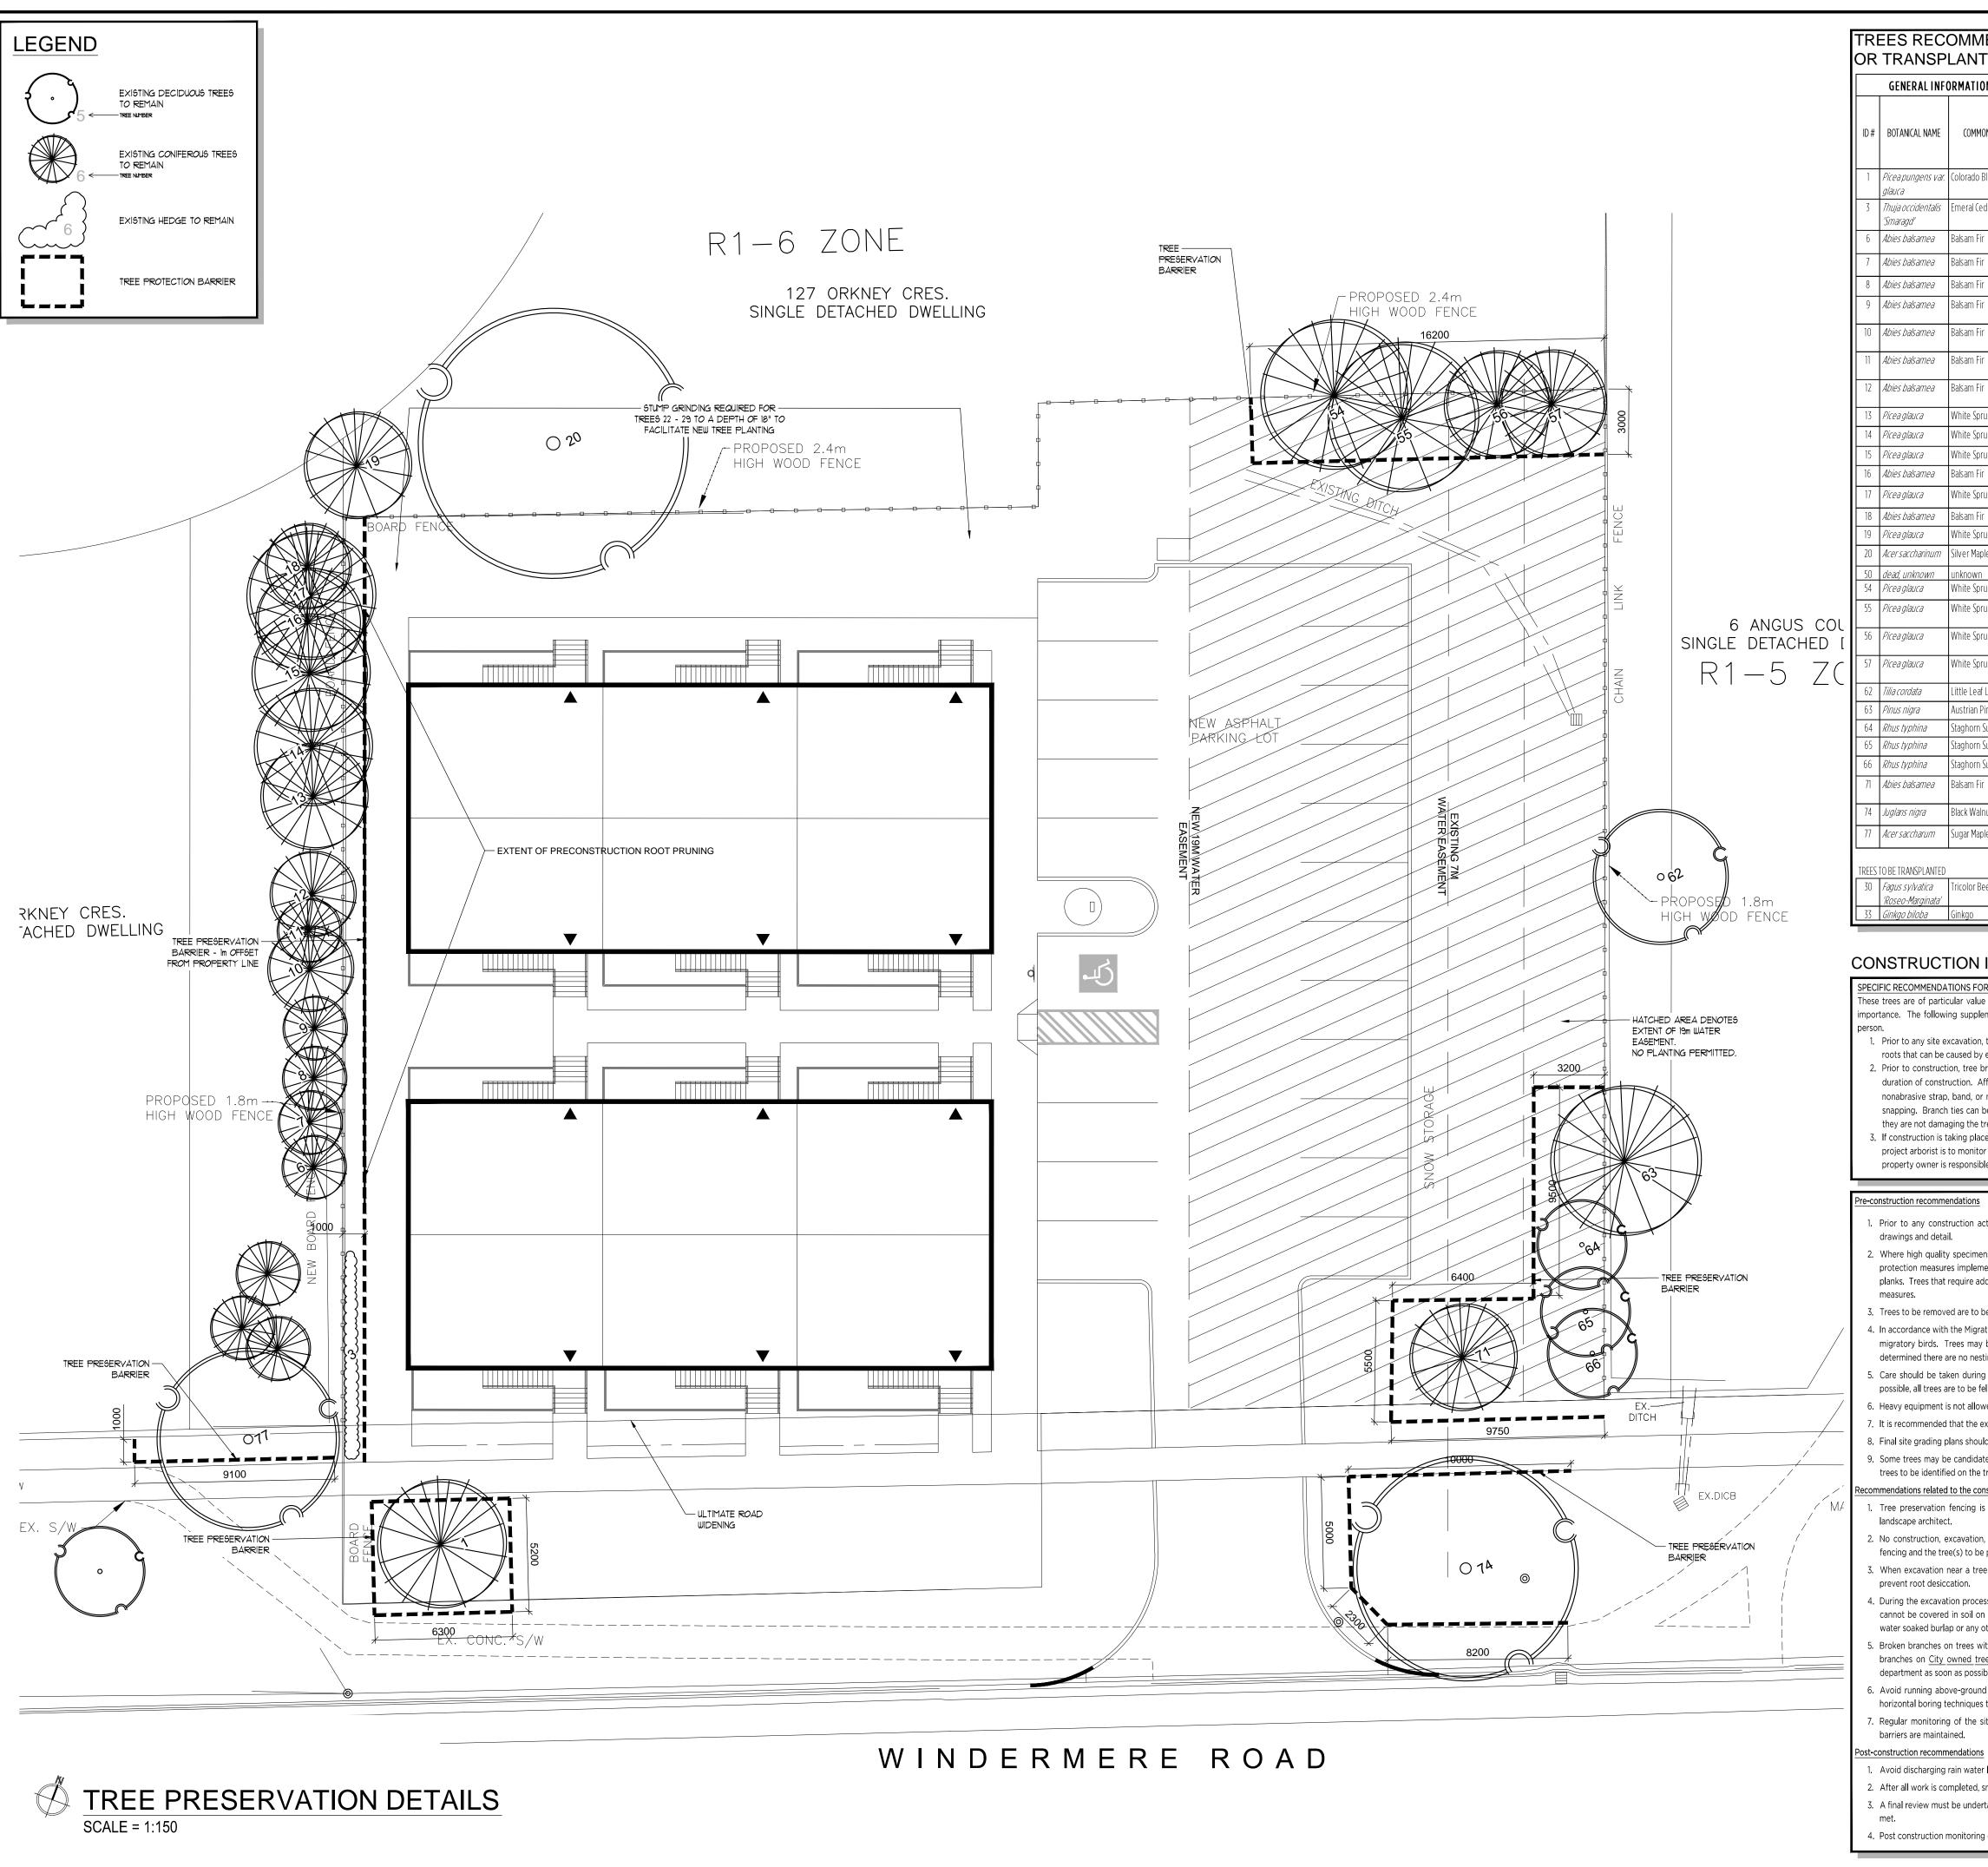



CONSTRUCTION IMPACT MITIGATION RECOMMENDATIONS

PECIFIC RECOMMENDATIONS FOR TREES 6 - 18

hese trees are of particular value to the community. Their preservation during construction and long term health following construction is of the upmost mportance. The following supplemental actions are to be carried out by an ISA certified arborist, experienced horticulture professional, or other qualified


1. Prior to any site excavation, trees are to have their roots cleanly cut in line with the tree preservation barriers. This root pruning will prevent damage to roots that can be caused by excavation with large machinery that can rip and pull at roots which would cause more harm than necessary.

2. Prior to construction, tree branches that extend past the tree preservation barrier and into the construction zone are to be temporarily bound for the duration of construction. Affected branches are to be gently guided back behind the tree preservation barrier and held in place using a flexible/elastic, nonabrasive strap, band, or material/cloth that is at least two inches wide. Branches are to be held back loosely, and not to be bent to the point of snapping. Branch ties can be secured to other tree parts or to the fence adjacent to the trees. Branch ties are to be monitored weekly to ensure that

they are not damaging the tree(s). Small adjustments to the points of attachment may be required over the period of construction. 3. If construction is taking place within the months of June to the end of September, trees are to be watered during extended dry weather conditions. The project arborist is to monitor the trees biweekly during this period and to inform the property owner in writing if and when tree watering is required. The property owner is responsible for promptly procuring this service.

e-construction recommendations

- 1. Prior to any construction activity or tree removal operations, tree preservation fencing is to be installed as per the attached tree preservation
- 2. Where high quality specimens to be preserved are adjacent to areas subject to intensive construction activities, these trees are to have additional protection measures implemented to protect their trunks from mechanical damage. These measures may include surrounding the trunk with wood planks. Trees that require additional protection will be clearly identified on the tree preservation plan with detailed information on specific protection
- 3. Trees to be removed are to be marked with spray paint by the arborist or landscape architect prior to any tree removal operations.
- 4. In accordance with the Migratory Birds Convention Act, 1994, all removals must take place from September 1st to April 1st to avoid disturbing nesting migratory birds. Trees may be removed outside this window (between April 2nd and August 31st) only if a qualified bird specialist/ecologist has determined there are no nesting birds in the trees.
- 5. Care should be taken during the felling operation to avoid damaging the branches, stems, trunks, and roots of the trees to be preserved. Where possible, all trees are to be felled towards the construction zone to minimize impacts on adjacent vegetation.
- 6. Heavy equipment is not allowed to idle under the drip line of trees to be preserved.
- 7. It is recommended that the existing ground-layer vegetation remain intact so as not to disturb the soil around the base of the existing trees. 8. Final site grading plans should ensure that the existing soil moisture conditions are maintained.
- 9. Some trees may be candidates for pre-construction root pruning to help reduce stress and prepare the tree for nearby construction activity. These trees to be identified on the tree preservation plan.
- ecommendations related to the construction process
- . Tree preservation fencing is to be maintained in good order until all heavy construction activity is complete or as per the project arborist or
- 2. No construction, excavation, adding of fill, stockpiling of construction material, or heavy equipment is permitted between the tree preservation
- fencing and the tree(s) to be protected. 3. When excavation near a tree is required, and it is anticipated that roots will be severed and exposed, duration of exposure is to be minimized to
- 4. During the excavation process, roots that are severed and exposed should be hand pruned to leave a clean-cut surface. Exposed severed roots that cannot be covered in soil on the same day as the cuts are made are to be kept moist. Exposed roots are to be kept moist by covering them with
- water soaked burlap or any other means available. 5. Broken branches on trees within the subject site to be preserved should be cleanly cut as soon as possible after the damage has occurred. Should branches on City owned trees be damaged by or during construction, the contractor is to notify the local municipal forestry or urban forestry
- department as soon as possible. No person(s) other than City staff or the City's designated contractor may perform work on any City tree. 6. Avoid running above-ground wires and underground services near trees to be preserved. Avoid open trenching within the tree root zone. Utilize
- horizontal boring techniques to install utilities within root zones. 7. Regular monitoring of the site by the project arborist or landscape architect will help to ensure proper procedures are followed and protection
- barriers are maintained.
- . Avoid discharging rain water leaders adjacent to retained trees. This may result in an overly moist environment which will cause the tree roots to rot. 2. After all work is completed, snow fences and other barriers should be removed.
- 3. A final review must be undertaken by the project arborist or landscape architect to ensure that all mitigation measures as described above have been
- 4. Post construction monitoring of trees may be required.

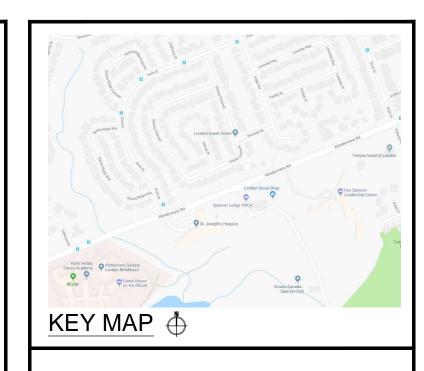



ALL DRAWINGS REMAIN THE PROPERTY OF THE LANDSCAPE ARCHITECT AND SHALL NOT BE REPRODUCED OR REUSED WITHOUT THE LANDSCAPE ARCHITECTS WRITTEN PERMISSION.


THIS DRAWING SHALL NOT BE USED FOR CONSTRUCTION OR TENDER PURPOSES UNLESS SIGNED AND DATED BY RONALD H. KOUDYS, OALA, CSLA, LANDSCAPE ARCHITECT, LONDON, ONTARIO (519) 667-3322.


Ronald H. Koudys, O.A.L.A. C.S.L.A. DATE

DEC 13, 2Ø19	ISSUED FOR TREE REPLACEMENT	8.
OCT 17, 2019	ISSUED FOR DISCUSSION	٦.
OCT Ø2, 2Ø19	ISSUED FOR SPA	6.
SEPT 27, 2019	ISSUED FOR REVIEW	5.
MAR 18, 2019	RE ISSUED FOR REZONING	4.
NOV 1, 2018	RE ISSUED FOR REZONING	3.
JULY 19, 2018	ISSUED FOR REZONING	2.
MAY 17, 2018	196UED FOR REVIEW	1.
DATE	DESCRIPTION	No.

PLOTTING INFORMATION:

PLOTTED DATE = DECEMBER 13, 2019 PLOTTED SCALE = 1:1

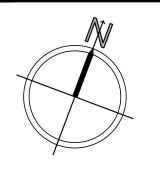

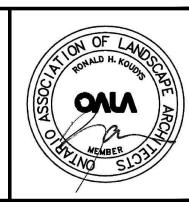



536-542 WINDERMERE RD

DRAWING TITLE:

TREE PRESERVATION DETAILS

DATE: MAY 2 <i>0</i> 18	SCALE: AS NOTED	DRAWING No.
DRAUN: RKLA Inc.	CHECKED BY: M.B.	T-2
PROJECT No. 18—		

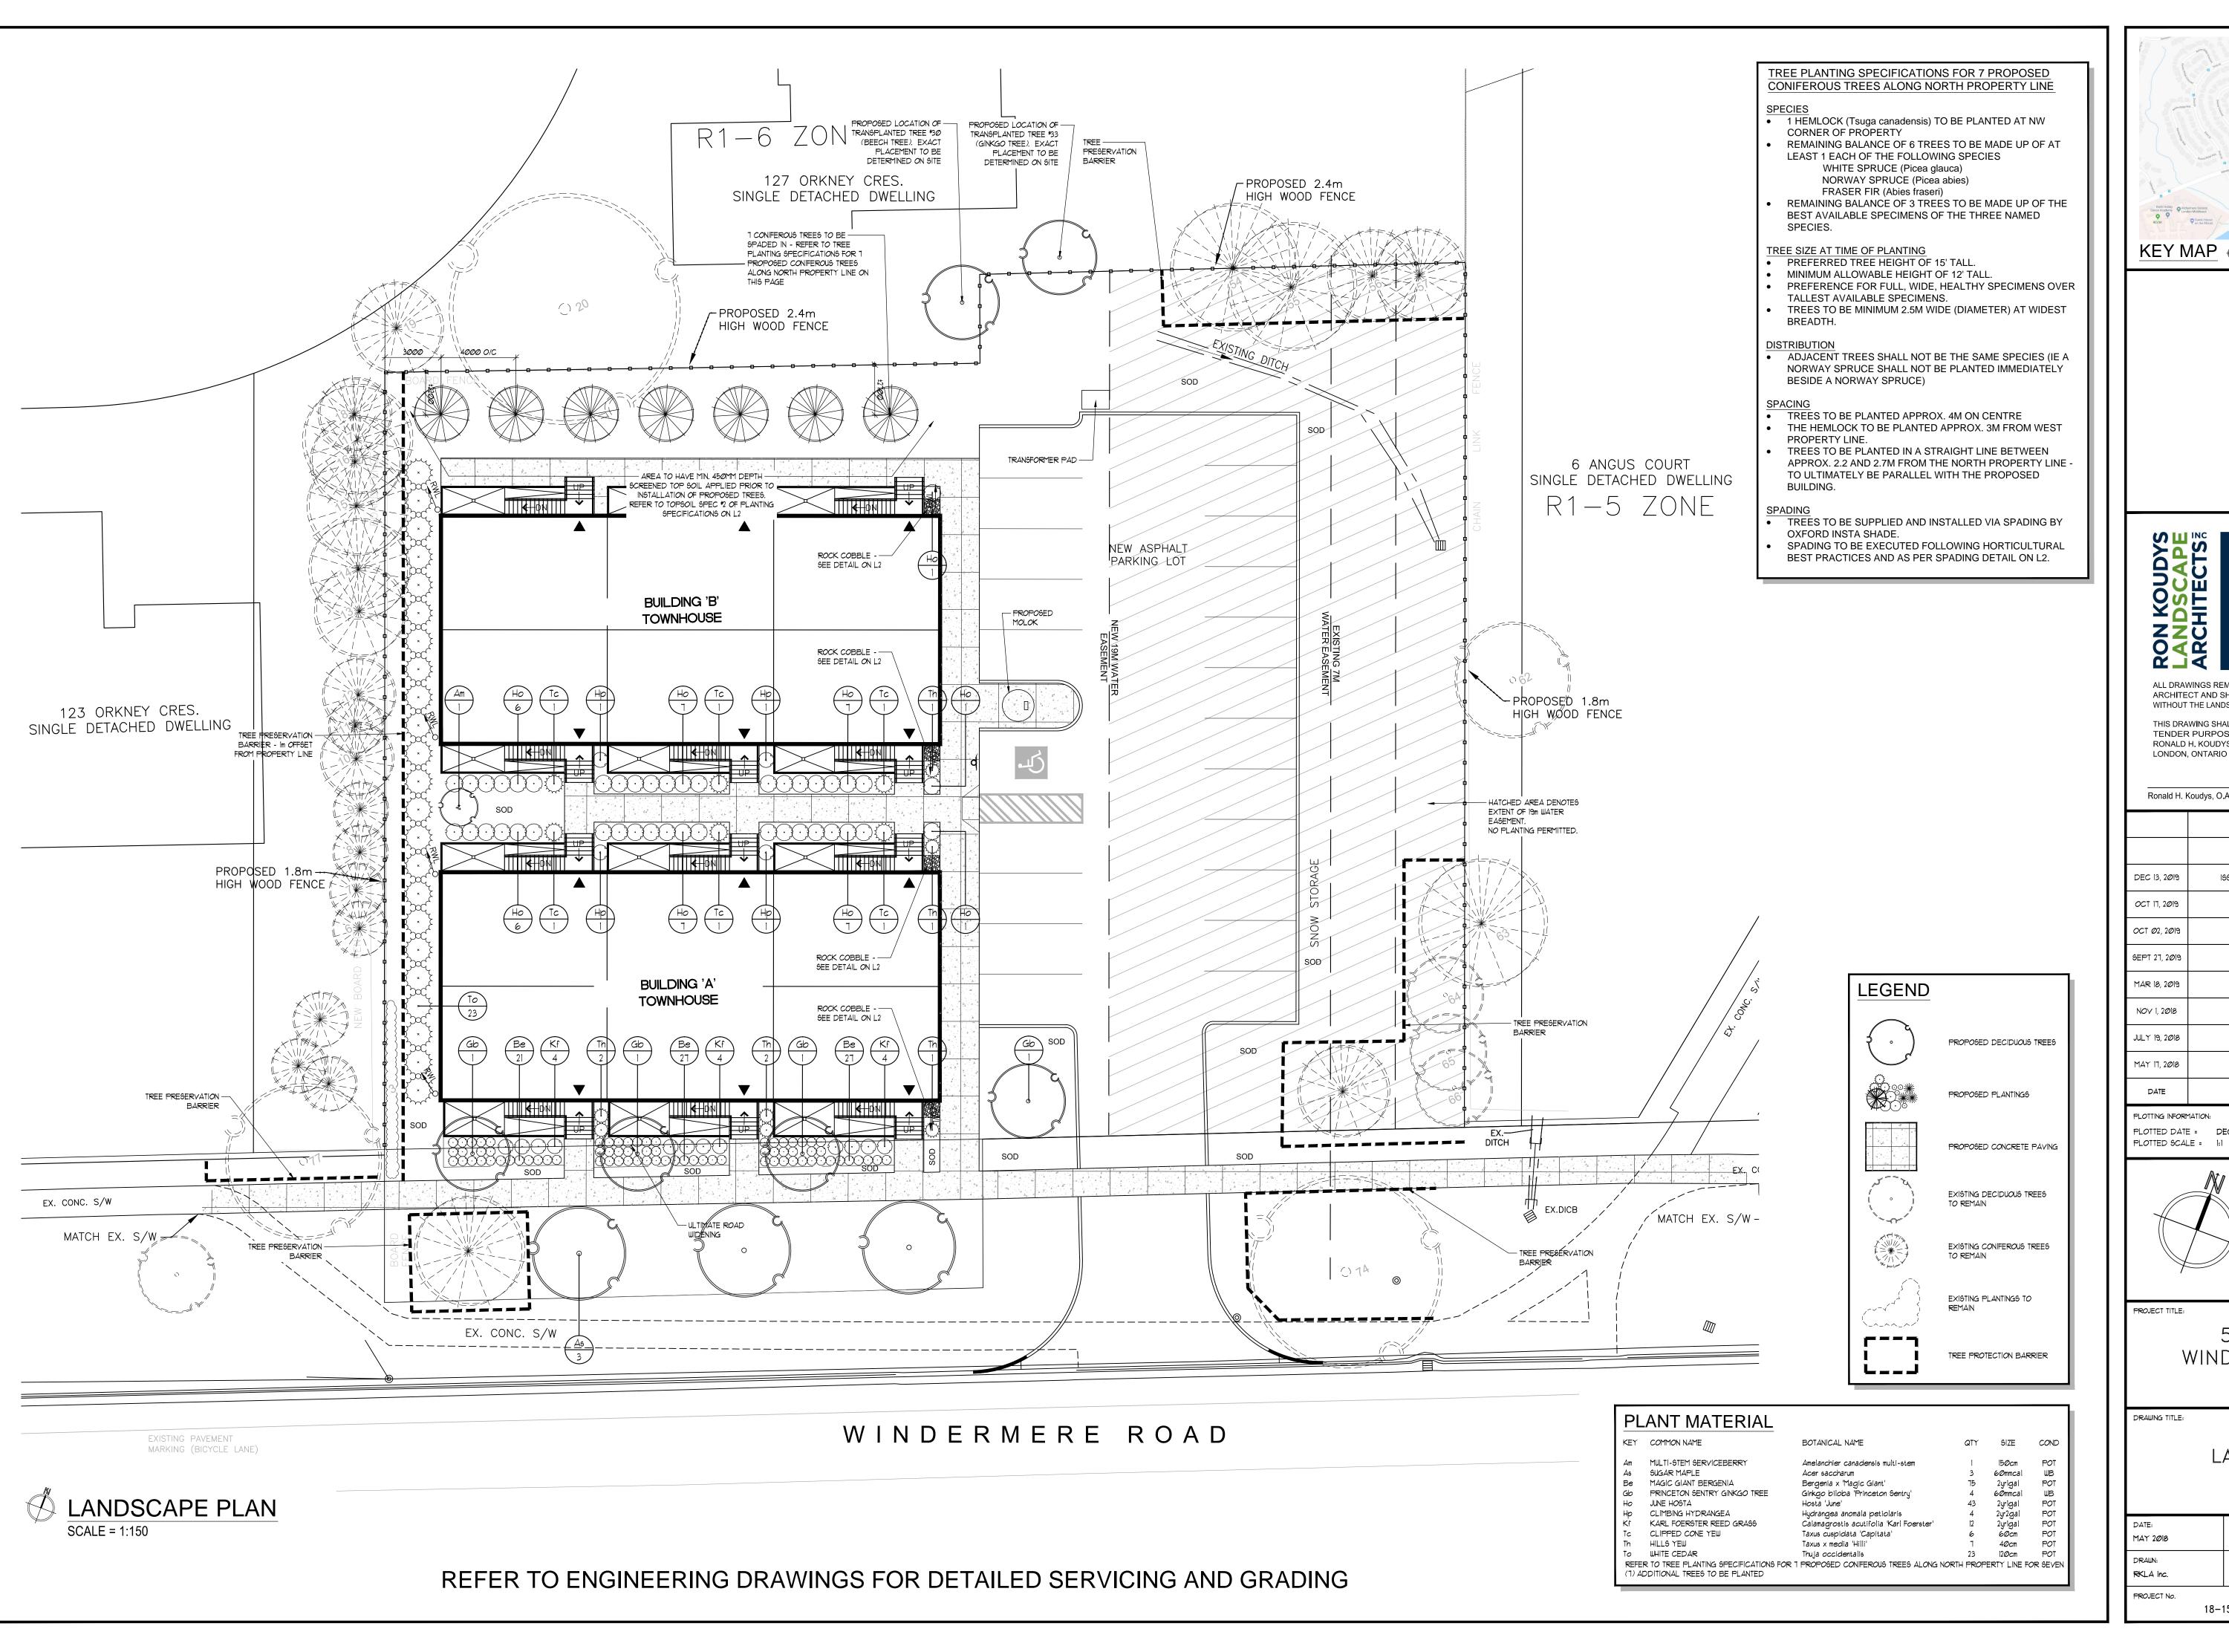

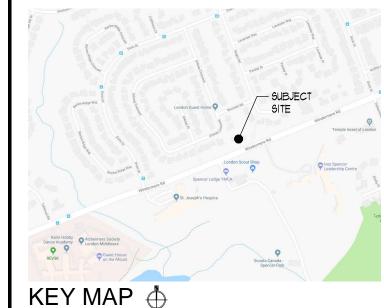



ALL DRAWINGS REMAIN THE PROPERTY OF THE LANDSCAPE


ARCHITECT AND SHALL NOT BE REPRODUCED OR REUSED WITHOUT THE LANDSCAPE ARCHITECTS WRITTEN PERMISSION.

THIS DRAWING SHALL NOT BE USED FOR CONSTRUCTION OR TENDER PURPOSES UNLESS SIGNED AND DATED BY RONALD H. KOUDYS, OALA, CSLA, LANDSCAPE ARCHITECT, LONDON, ONTARIO (519) 667-3322.

Ronald H. Koudys, O.A.L.A. C.S.L.A. DATE

	DEC 13, 2Ø19	ISSUED FOR TREE REPLACEMENT	8.
	OCT 17, 2019	ISSUED FOR DISCUSSION	٦.
	OCT Ø2, 2019	ISSUED FOR SPA	6.
	SEPT 27, 2019	ISSUED FOR REVIEW	5.
	MAR 18, 2019	RE ISSUED FOR REZONING	4.
	NOV 1, 2018	RE ISSUED FOR REZONING	3.
	JULY 19, 2018	199UED FOR REZONING	2.
	MAY 17, 2018	ISSUED FOR REVIEW	1.
	DATE	DESCRIPTION	No.

PLOTTING INFORMATION: PLOTTED DATE = DECEMBER 13, 2019

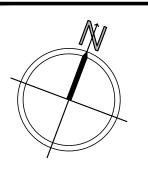




PROJECT TITLE:


536-542 WINDERMERE RD LONDON, ON


DRAWING TITLE:


LANDSCAPE PLAN

DATE: MAY 2018	9CALE: AS NOTED	DRAWING No.
DRAWN: RKLA Inc.	CHECKED BY: M.B.	
PROJECT No. 18-152Lu		

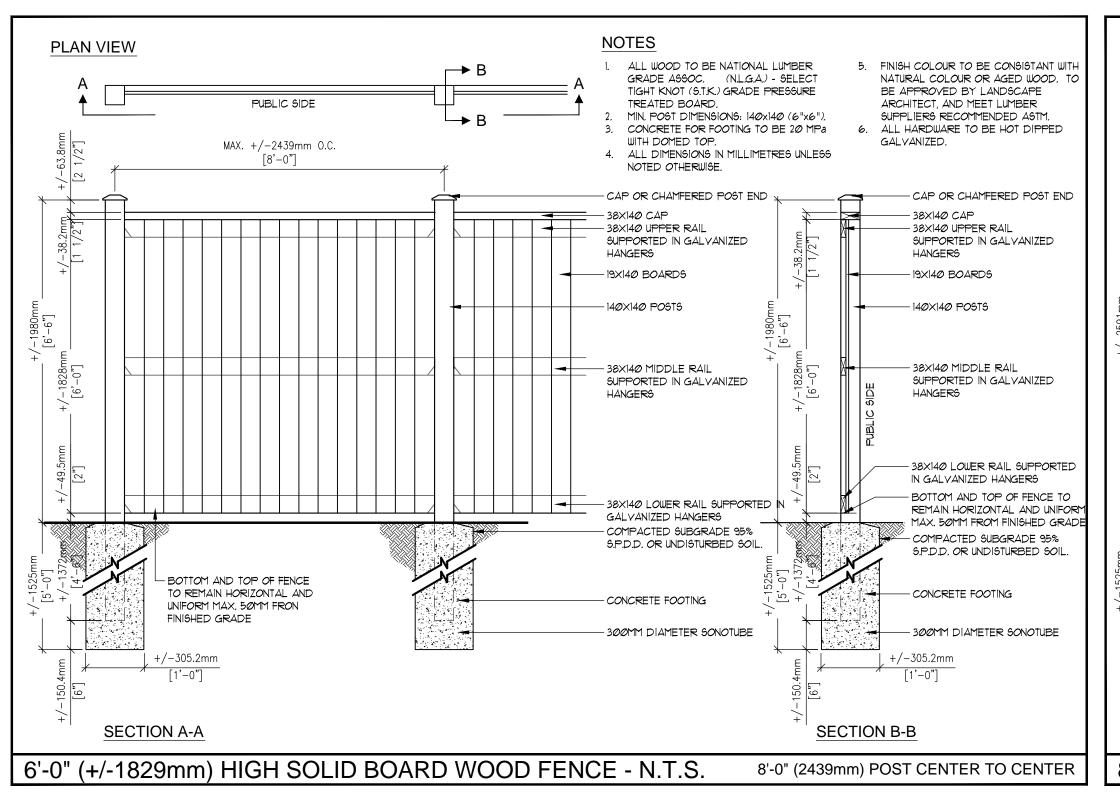

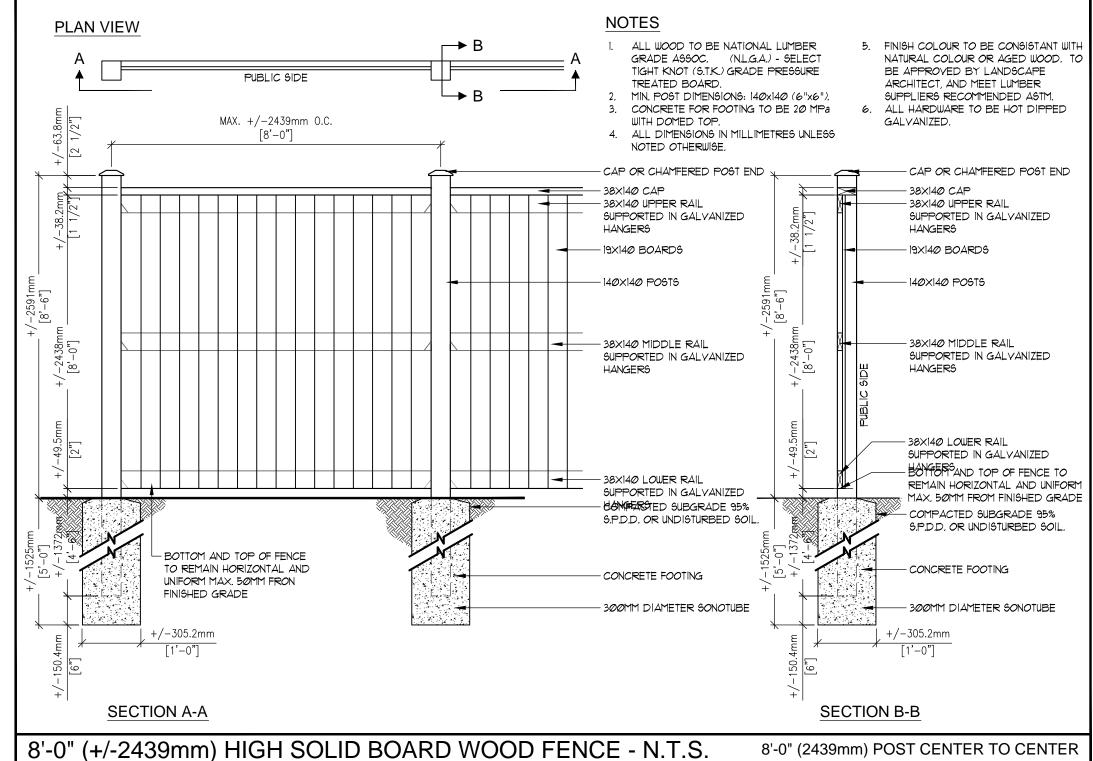

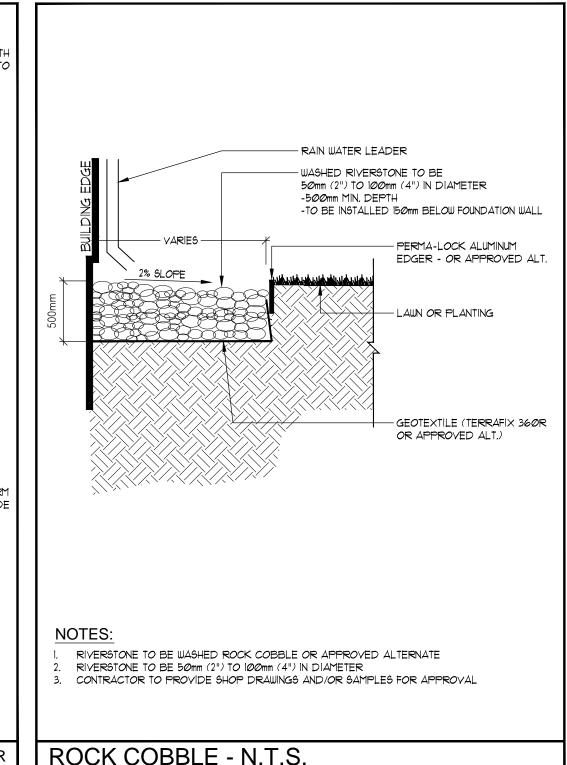


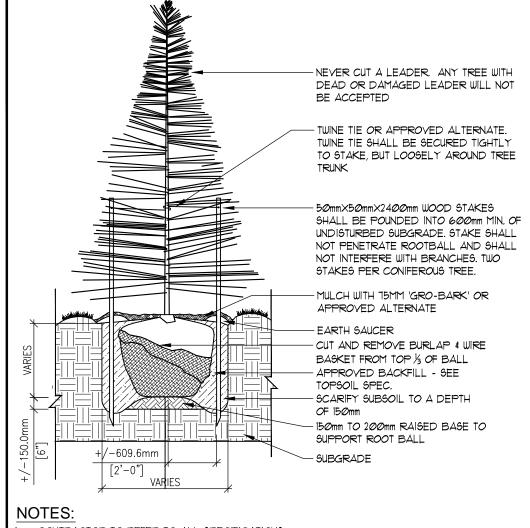

CONTRACTOR TO REFER TO ALL SPECIFICATIONS. ALL PLANTS TO CONFORM TO CNLA - CANADIAN STANDARDS FOR NURSERY STOCK. GIVE LANDSCAPE ARCHITECT 48 HOURS NOTICE PRIOR TO INSTALLATION TO INSPECT PLANT

MATERIAL AND PIT PREPARATION - SEE GENERAL SPECIFICATIONS.

- DO NOT ALLOW AIR POCKETS WHEN BACKFILLING. POSITION CROWN OF ROOT BALL 50MM ABOVE FINISHED GRADE TO ALLOW FOR SETTLING. TREE PIT SIZE TO BE MIN. 300MM WIDER THAN ROOT BALL
- TREES UNDER 450CM HIGH REQUIRE TWO STAKES. TREES 450CM HIGH AND GREATER REQUIRE
- THREE STAKES. ALL STAKES TO BE REMOVED AFTER 2 YEARS. DO NOT DAMAGE MAIN ROOTS WHEN INSTALLING STAKES.
- NO TREE PIT SHALL BE LEFT OPEN OVERNIGHT. 0. ALL CONIFEROUS TREES TO BE WRAPPED FOR THE FIRST WINTER AFTER INSTALLATION.
- THE ABOVE DOES NOT REPRESENT ANY PARTICULAR SPECIES. ALL DIMENSIONS SHOWN IN MILLIMETERS. INSTALL 15MM OF APPROVED MULCH.
- CONIFEROUS TREE PLANTING DETAIL N.T.S.

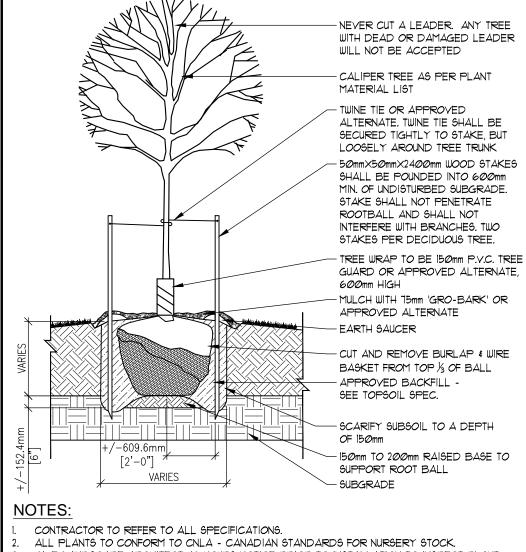

- GIVE LANDSCAPE ARCHITECT 48 HOURS NOTICE PRIOR TO INSTALLATION TO INSPECT PLANT MATERIAL AND PIT PREPARATION - SEE GENERAL SPECIFICATIONS.
- DO NOT ALLOW AIR POCKETS WHEN BACKFILLING. TREE PIT SIZE TO BE MIN. 300mm WIDER THAN ROOT BALL
- TREE SHALL BEAR SAME RELATION TO GRADE AS IT BORE TO ITS PREVIOUS EXISTING GRADE. PLANT TREE 50 - 100mm ABOVE DESIRED GRADE TO ALLOW FOR SOME SETTLING.
- DO NOT DAMAGE MAIN ROOTS WHEN INSTALLING STAKES. TREES UNDER 10mm CALIPER REQUIRE TWO STAKES. TREES 10mm CALIPER AND GREATER
- REQUIRE THREE STAKES. REMOVE STAKES AFTER 2 YEARS. NO TREE PIT SHALL BE LEFT OPEN OVERNIGHT.
- THE ABOVE DOES NOT REPRESENT ANY PARTICULAR SPECIES. ALL DIMENSIONS SHOWN IN MILLIMETERS.
- INSTALL 15mm OF APPROVED MULCH.

DECIDUOUS TREE PLANTING DETAIL - N.T.S.

EQUAL DISTANCE - REMOVE ANY BROKEN, DEAD OR DISEASED BRANCHES ACCORDING TO STANDARD 100mm TOPSOIL -HORTICULTURAL PRACTICES SAUCER SIDES TO - BEST SIDE TOWARD VIEW BE MAX. 5:1 SLOPE /____ MULCH WITH 75mm 'GRO-BARK OR APPROVED ALTERNATE SEE NOTE #11 SEE NOTE #12 — SCARIFY SUBSOIL TO A DEPTH OF 150mm - SUBGRADE / EXISTING SOIL 1.2m MINIMUM 1.2m MINIMUM OTHERWISE SEE NOTE #13 ---NOTED BUILDING -BUILDING -EDGE PLAN VIEW (NEXT TO BUILDING) LEVATION (NEXT TO BUILDING)

- CONTRACTOR TO REFER TO ALL SPECIFICATIONS. ALL PLANTS TO CONFORM TO CNLA - CANADIAN STANDARDS FOR NURSERY STOCK.
- GIVE LANDSCAPE ARCHITECT 48 HOURS NOTICE PRIOR TO INSTALLATION TO INSPECT PLANT MATERIAL AND PIT PREPARATION - SEE GENERAL SPECIFICATIONS.
- DO NOT ALLOW AIR POCKETS WHEN BACKFILLING. POSITION CROWN OF ROOT BALL 50MM ABOVE FINISHED GRADE TO ALLOW FOR SETTLING.
- PLANTING METHOD ILLUSTRATED SHALL APPLY TO BARE ROOT STOCK AND BALLED STOCK. SHRUBS PLANTED IN GROUPS SHALL BE SET IN CONTINUOUS BED.
- THE ABOVE DETAIL DOES NOT REPRESENT ANY PARTICULAR SPECIES. ALL DIMENSIONS SHOWN IN MILLIMETERS.
- INSTALL 15MM OF APPROVED MULCH.
- PEEL BACK TOP 1/3 OF BURLAP, DO NOT REMOVE. CUT AND REMOVE ALL ROPE FROM TOP HALF OF ROOT BALL (B&B PLANT MATERIALS). REMOVE PLANTS FROM PLASTIC CONTAINERS
- (CONTAINER GROWN MATERIALS)
- COMPACTED TOPSOIL TO BE TAMPED TO MINIMIZE SETTLEMENT.

PREPARED TOPSOIL TO BE 50% NATIVE TOPSOIL, FREE OF STONES, LUMPS OF CLAY GREATER THAN 25mm (IINCH) AND ALL ROOTS OR OTHER EXTRANEOUS MATERIAL, AMEND WITH 50% TRIPLE MIX: MAX. 1/3 OF PLANTING BED DEPTH MAY BE ABOVE GRADE WHERE SOILS ARE HEAVILY ALL SHRUBS TO BE PLANTED A MINIMUM OF 12m ON CENTER AWAY FROM ALL BUILDING EDGES UNLESS OTHERWISE NOTED. SHRUB PLANTING DETAIL - N.T.S.

- NEVER CUT A LEADER. ANY TREE WITH DEAD OR DAMAGED LEADER WILL NOT BE ACCEPTED TWINE TIE OR APPROVED ALTERNATE, TWINE TIE SHALL BE SECURED TIGHTLY TO STAKE, BUT LOOSELY AROUND TREE TRUNK -50mm×50mm×2400mm WOOD STAKES SHALL BE POUNDED INTO 600mm MIN OF UNDISTURBED SUBGRADE, STAKE SHALL NOT PENETRATE ROOTBALL AND SHALL NOT INTERFERE WITH BRANCHES, MIN. THREE STAKES PER CONIFEROUS TREE. MIN. 2 STAKES PER DECIDUOUS TREE -MULCH WITH 15MM 'GRO-BARK' OR APPROVED ALTERNATE EARTH SAUCER FINISHED GRADE - ROOT PLUG, REFER TO SPECIFICATIONS FOR MINIMUM SIZE -UNDISTURBED SOIL SCARIFY TOP 450MM OF PLANTING HOLE AND REMOVE ANY WATER PRIOR TO PLANTING TREE

- TRANSPLANTING TO BE COMPLETED DURING THE DORMANT SEASON ONCE MOST OF THE FROST HAS LEFT THE GROUND AND BEFORE BUD BREAK. TYPICALLY BETWEEN FEBRUARY AND APRIL. HYDRAULIC SPADE USED TO BE BASED ON SIZE OF TREE - REFER TO SIZE CHART BELOW. DIG TREE HOLE WITH SAME HYDRAULIC SPADE USED TO TRANSPLANT TREE.
- DO NOT ALLOW AIR POCKETS WHEN BACKFILLING. POSITION TREE AT SAME DEPTH AS ORIGINAL LOCATION.
- TREES UNDER 4M HEIGHT REQUIRE TWO STAKES. TREES OVER 4M HEIGHT REQUIRE THREE
- STAKES. ALL STAKES TO BE REMOVED AFTER 2 YEARS. DO NOT DAMAGE ROOTS WHEN INSTALLING STAKES. TREE TO BE THOROUGHLY WATERED FOLLOWING TRANSPLANTING AND STAKING TO ELIMINATE
- ANY AIR POCKETS. NO TREE PIT SHALL BE LEFT OPEN OVERNIGHT.
- THE ABOVE DETAIL DOES NOT REPRESENT ANY PARTICULAR SPECIES.
- ALL DIMENSIONS SHOWN IN MILLIMETERS. INSTALL 15MM OF APPROVED MULCH.

1070 mm (42") 75-100 mm (3-4") 132Ø mm (52") 125-150 mm (5-6") 1575 mm (62") 150-175 mm (6-7") 2030 mm (80") 200-250 mm (8-10") 228Ø mm (9Ø") 25Ø-3ØØ mm (1Ø-12")

MAX TREE CALIPER

SPADE SIZE

TREE SPADE TRANSPLANTING DETAIL - N.T.S.

GENERAL PLANTING SPECIFICATIONS:

- BASE INFORMATION SUPPLIED BY ZELINKA PRIAMO LTD. ENGINEERING INFORMATION SUPPLIED BY ENG PLUS.
- CONTRACTOR TO MAKE THEMSELVES FAMILIAR WITH ALL RELATED SPECIFICATIONS. CONTRACTORS ARE RESPONSIBLE FOR REVIEW OF ALL SPECIFICATIONS AND RELATED DRAWINGS WITH SELECTED SUB-CONTRACTORS AS
- THEY PERTAIN TO WORK AS OUTLINED ON LANDSCAPE ARCHITECTURAL WORKING DRAWINGS AND SPECIFICATIONS. 5. REPORT ALL DISCREPANCIES TO THE LANDSCAPE ARCHITECT DURING TENDERING PROCESS, ERRORS AND/OR OMISSIONS WILL BE THE 6. CONTRACTOR SHALL MAINTAIN ALL LANDSCAPED AREAS UNTIL OWNER ACCEPTANCE OF PROJECT. CONTRACTOR TO NOTIFY LANDSCAPE
- ARCHITECT IN WRITING ON COMPLETION OF PROJECT FOR A SITE WORK COMPLETION CERTIFICATE AS WELL AS THE COMMENCEMENT OF THE ACCEPTANCE OF PROJECT 1. ALL WORKMANGHIP TO BE WARRANTIED FOR ONE YEAR UNLESS OTHERWISE STATED. WARRANTY PERIOD WILL BEGIN ON FINAL ACCEPTANCE
- 8. ALL WORKMANSHIP TO COMPLY WITH THE CANADIAN LANDSCAPE STANDARDS. 9. ALL NURSERY STOCK TO BE #1 NURSERY GROWN AND MUST COMPLY WITH "GUIDE SPECIFICATION FOR NURSERY STOCK OF THE CANADIAN
- NURSERY TRADES ASSOCIATION." 10. ALL LANDSCAPING IS TO BE INSTALLED PRIOR TO THE END OF THE FIRST GROWING SEASON FOLLOWING THE OCCUPANCY OF THE SITE DEVELOPMENT UNLESS OTHERWISE STATED.
- II. CONTRACTOR IS RESPONSIBLE FOR ALL UNDERGROUND UTILITIES AND MUST SUPPLY THE LANDSCAPE ARCHITECT WITH COPIES OF LOCATE CERTIFICATES PRIOR TO COMMENCEMENT OF WORK.

<u>GRADING</u> 1. CONTRACTOR TO ENSURE POSITIVE DRAINAGE IN ALL AREAS. ALL GRADING TO BE IN ACCORDANCE WITH SITE ENGINEERS DRAWINGS.

- SOIL SHALL BE SCARIFIED FREE OF ALL STONES, ROOTS, BRANCHES LARGER THAN I" (25MM) AND COMPACTED TO 85% S.P.D. ALL SUBSOIL TO BE SCARIFIED TO A DEPTH OF 6" (150 MM) PRIOR TO THE INSTALLATION OF TOPSOIL TO ENSURE NO HARDPAN CONDITIONS.
- CONTRACTOR TO NOTIFY LANDSCAPE ARCHITECT PRIOR TO INSTALLATION OF TOPSOIL TO APPROVE SUBBASE. DIRECT ALL RAINLEADERS AND SUMP LEADERS AWAY FROM PLANTING BEDS AND TO THE DESIGNATED SWALES.
- NOTIFY LANDSCAPE ARCHITECT IN WRITING OF ANY SUBSTANTIAL WET CONDITIONS.

AT THE CONTRACTORS EXPENSE A SOIL TEST IS TO BE COMPLETED BY A REPUTABLE LABORATORY. THE SOIL TEST IS TO BE COMPLETED AND IF NECESSARY, RECOMMENDATIONS FROM THE LABORATORY ARE TO BE INCLUDED. THE RESULTS OF SOIL TESTS AND RECOMMENDATIONS ARE TO BE PROVIDED TO THE LANDSCAPE ARCHITECT FOR APPROVAL ONE WEEK PRIOR TO WORK COMMENCING. TOPSOIL FOR PLANTING BEDS INCLUDING AREA WITH TREES TO BE SPADED IN 15 TO BE A FERTILE, FRIABLE, NATURAL LOAM TO A MINIMUM DEPTH OF 18" (450MM), AND A MINIMUM DEPTH OF 4" (100MM) FOR TURF AREAS - UNLESS OTHERWISE STATED - TOPSOIL SHALL CONTAIN NOT LESS THAN 4% ORGANIC MATTER FOR CLAY LOAMS AND NOT LESS THAN 2% ORGANIC MATTER'S FOR SANDY LOAM TO A MAXIMUM OF 15%,


AND CAPABLE OF SUSTAINING VIGOROUS PLANT GROWTH, FREE OF SUBSOIL CONTAMINATION, ROOTS AND STONES OVER 50MM DIAMETER, REASONABLY FREE OF WEEDS, AS DETERMINED BY THE LANDSCAPE ARCHITECT, AND HAVING A PH RANGING FROM 6.0 TO 1.0.

- ALL TREEPITS, SHRUB PITS AND PLANTING AREAS ARE TO BE MULCHED UNLESS OTHERWISE NOTED. CONTRACTOR TO INSTALL 3" (15MM) OF 'GRO-BARK' MEDIUM MULCH IN ALL AREAS.
- 3. ALTERNATIVES MAY BE ACCEPTED CONTRACTOR TO PROVIDE 3 SAMPLES FOR WRITTEN APPROVAL TO THE LANDSCAPE ARCHITECT.
- CONTRACTOR TO VERIFY ALL PLANT MATERIAL ON DRAWING(S) AND PLANT MATERIAL LIST(S), REPORT ALL DISCREPANCIES AT TENDERING
- SUBSTITUTIONS WILL NOT BE ACCEPTED WITHOUT WRITTEN CONFIRMATION BY THE LANDSCAPE ARCHITECT. 3. PLANTINGS MAY BE ADJUSTED TO SUIT UTILITIES STRUCTURES AND AESTHETIC CONCERNS, ADJUSTMENTS ARE TO BE MADE UNDER THE DIRECTION OF THE LANDSCAPE ARCHITECT. ADJUSTMENTS TO PLANTING WITHOUT CONSENT OF LANDSCAPE ARCHITECT AND OR PROJECT MANAGER MAY NOT MEET INTENT OF DESIGN AND OR MUNICIPAL APPROVALS. PLANT MATERIAL THAT HAS TO BE RELOCATED AS A RESULT
- WILL BE AT THE COST OF THE CONTRACTOR. 4. LANDSCAPE ARCHITECT TO INSPECT ALL PLANT MATERIAL ON SITE OR AT ITS SOURCE PRIOR TO INSTALLATION. CONTRACTOR IS TO GIVE
- LANDSCAPE ARCHITECT 48 (HRS) NOTICE FOR INSPECTION. 5. CONTRACTOR TO NOTIFY LANDSCAPE ARCHITECT IN WRITING IF ADVERSE WEATHER MAY IMPACT THE HEALTH OF THE PLANT MATERIALS AT
- TIME OF PLANTING. IE. TEMPERATURE, PRECIPITATION. 6. ALL TREE PITS SHALL BE AT LEAST 2 FT. (600MM) WIDER THAN BALL OF THE TREE TO BE PLANTED AND SHALL BE DEEP ENOUGH SO THAT THE TOP OF BALL IS AT THE SAME LEVEL AS SURROUNDING GRADE. A MINIMUM OF 6" (ISOMM) OF BACKFILL SHALL BE PLACED UNDER BALL. TREE PITS ARE NOT TO BE LEFT OPEN OVER NIGHT.
- SHRUB BEDS SHALL BE EXCAVATED TO A DEPTH OF 18" (450MM) AND FILLED WITH APPROVED BACKFILL MATERIAL. SHRUB BEDS ARE NOT TO BE LEFT OPEN OVER NIGHT.
- 8. ALL TREES SHALL HAVE AN EARTH SAUCER AT ITS BASE WITH A DIAMETER AS LARGE AS EXCAVATED AREA AND SHAPED TO RETAIN WATER (SEE DETAIL). EARTH SAUCER TO HAVE APPROVED MULCH INSTALLED TO A MINIMUM DEPTH OR 2.5" (63MM). 9. ALL BURLAP SHALL BE CUT AND BURIED BELOW SURFACE DURING PLANTING.
- IØ. ALL EVERGREENS ARE TO WRAPPED THE FIRST WINTER AT THE EXPENSE OF THE LANDSCAPE CONTRACTOR. II. ALL SHRUBS PLANTED WITHIN IM OF SALTED ROADWAYS, PARKING AND SIDEWALKS TO BE PROTECTED WITH SILT FENCING THROUGHOUT THE FIRST WINTER AFTER INSTALLATION AT THE EXPENSE OF THE LANDSCAPE CONTRACTOR (OPTIONAL)
- 12. DIRECT ALL RAINLEADERS AND SUMP LEADERS AWAY FROM PLANTING BEDS AND TO DESIGNATED DRAINAGE SWALES. 13. DO NOT INSTALL PLANT MATERIAL IN DRAINAGE SWALES.
- 14. CONTRACTOR IS TO REMOVE ALL STAKES AND GUY WIRES AFTER 2 FULL GROWING SEASONS.

ALL LANDSCAPED AREAS TO BE SODDED TO THE STREET CURB (S) UNLESS OTHERWISE STATED.

- CONTRACTOR TO ENSURE (WHERE APPLICABLE) ALL PLANTING BEDS ADJACENT TO TRAFFIC ISLANDS, INTERIOR SITE CURBING, AND SIDEWALKS HAVE A 3'0"(1.0M) SOD MAINTENANCE STRIP INSTALLED.
- ANY SODDING OR WORKS ON LANDS ABUTTING THE PROPERTY FROM THE LOTLINES TO SIDEWALK AND CURBING, SHALL BE COMPLETED OR REPAIRED TO THE SATISFACTION OF THE LANDSCAPE ARCHITECT, CITY, AND OR REGIONAL MUNICIPALITY UNLESS OTHERWISE STATED. SOD SHALL BE CERTIFIED * I CULTIVATED TURF GRASS, GROWN AND SOLD IN ACCORDANCE WITH THE CLASSIFICATIONS OF THE NURSERY SOD GROWERS ASSOCIATION OF ONTARIO. AT TIME OF SALE IT SHALL HAVE A STRONG FIBROUS ROOT SYSTEM AND SHALL BE CUT IN PIECES APPROXIMATELY ONE 5Q.YD (900 M2) IN AREA WITH THE SOIL PORTION BEING 3/4" IN.(19MM).
- 50D TO BE FERTILIZED AT THE APPROPRIATE RATES AS INDICATED BY SOIL TESTS COMPLETED BY A REPUTABLE SOILS LABORATORY. 6. UPON INSTALLATION AREAS SHOULD BE WATERED SO AS TO SATURATE SOD AND THE UPPER 4" (100MM) OF BACKFILL TOPSOIL. AFTER SOD AND SOIL HAVE DRIED SUFFICIENTLY TO PREVENT DAMAGE, IT SHALL BE ROLLED WITH A ROLLER PROVIDING 1500 LBS. (681KG)
- CONTRACTOR TO REPAIR ALL DAMAGED AREAS TO THE SATISFACTION OF THE LANDSCAPE ARCHITECT AND OR CLIENT.

- DURING THE WARRANTY PERIOD, BETWEEN MAY 15 AND SEPTEMBER 15 OF EACH YEAR, WATERING OF ALL PLANTS SHALL BE CARRIED OUT NO LESS THAN 6 TIMES PER YEAR, IN ACCORDANCE WITH THE WATERING SCHEDULE TO BE DETERMINED BY THE OWNER, UNLESS OTHERWISE
- STATED ON THE DRAWINGS. CRITICAL WATERING MONTHS ARE JUNE, JULY & AUGUST IF NO AUTOMATED IRRIGATION SYSTEM HAS BEEN PROVIDED FOR WATERING OPERATIONS, CONTRACTOR TO PROVIDE WATER TO THE SITE IF HOSE BIBS WITHIN THE BUILDING ENVELOPE ARE NOT AVAILABLE.
- 3. MANUAL WATERING SHOULD ENSURE DEEP WATERING OF TREES, SHRUBS, GROUND COVERS AND GRASSED AREAS. WATERING OF GRASSED AREAS TO COMMENCE ON A REGULAR BASIS AND CONTINUE WITH INTENSITY DEPENDING ON AMOUNT OF RAINFALL. NEW SOD THAT HAS BEEN LAID SHOULD BE KEPT MOIST FOR 4 TO 5 WEEKS OR UNTIL IT HAS FIRMLY ROOTED INTO THE EXISTING SOIL. ALL CONIFEROUS TREES SHALL BE WATERED IN LATE FALL, JUST PRIOR TO FREEZE-UP.
- WATER SHALL BE APPLIED SO THAT THE WASHING OF THE SOIL OR DISLODGING OF MULCH OR TREE GUARDS DOES NOT OCCUR. DAMAGE SHALL BE IMMEDIATELY REPAIRED TO THE SATISFACTION OF THE OWNER AT NO ADDITIONAL COST.

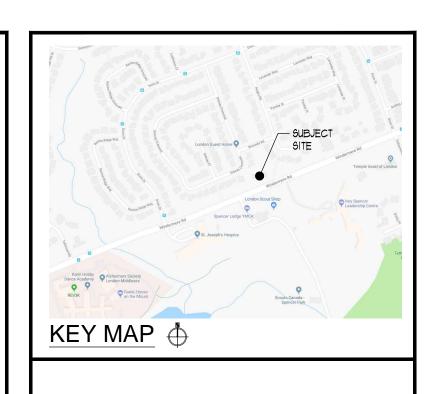



ALL DRAWINGS REMAIN THE PROPERTY OF THE LANDSCAPE ARCHITECT AND SHALL NOT BE REPRODUCED OR REUSED WITHOUT THE LANDSCAPE ARCHITECTS WRITTEN PERMISSION.


THIS DRAWING SHALL NOT BE USED FOR CONSTRUCTION OR TENDER PURPOSES UNLESS SIGNED AND DATED BY RONALD H. KOUDYS, OALA, CSLA, LANDSCAPE ARCHITECT, LONDON, ONTARIO (519) 667-3322.

Ronald H. Koudys, O.A.L.A. C.S.L.A. DATE

Ronald H. Koudys, O.A.L.A. C.S.L.A. DATE				
DEC 13, 2Ø19	ISSUED FOR TREE REPLACEMENT	8.		
OCT 17, 2019	ISSUED FOR DISCUSSION	٦.		
OCT Ø2, 2Ø19	ISSUED FOR SPA	6.		
SEPT 27, 2019	ISSUED FOR REVIEW	5.		
MAR 18, 2019	RE 199UED FOR REZONING	4.		
NOV 1, 2018	RE 199UED FOR REZONING	3.		
JULY 19, 2018	199UED FOR REZONING	2.		
MAY 17, 2018	ISSUED FOR REVIEW	1.		
DATE	DESCRIPTION DESCRIPTION	No.		

PLOTTING INFORMATION:

PLOTTED DATE = DECEMBER 13, 2019 PLOTTED SCALE = 1:1

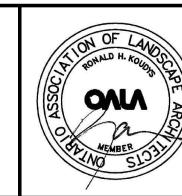

PROJECT TITLE:

536-542 WINDERMERE RD LONDON, ON

DRAWING TITLE:

LANDSCAPE DETAILS

DATE: MAY 2018	SCALE: AS NOTED	DRAWING No.	
DRAWN: RKLA Inc.	CHECKED BY: M.B.	L-2	
PROJECT No.			